


(1)ALL WINDOW DIMENSION


OUTSIDE WALL TO MIDDLE OF INTERIOR WALL, UNLESS


WALL BRACING WORKSHEET


| DATE | REVISIONS |
|---------|-------------|
| 4/21/22 | CHECK SET |
| 5/5/22 | BIDDING SET |
| 7/13/22 | FRAMING |
| 7/26/22 | PERMIT SET |
| | |
| | |
| | |
| | |
| | |


A-1.2

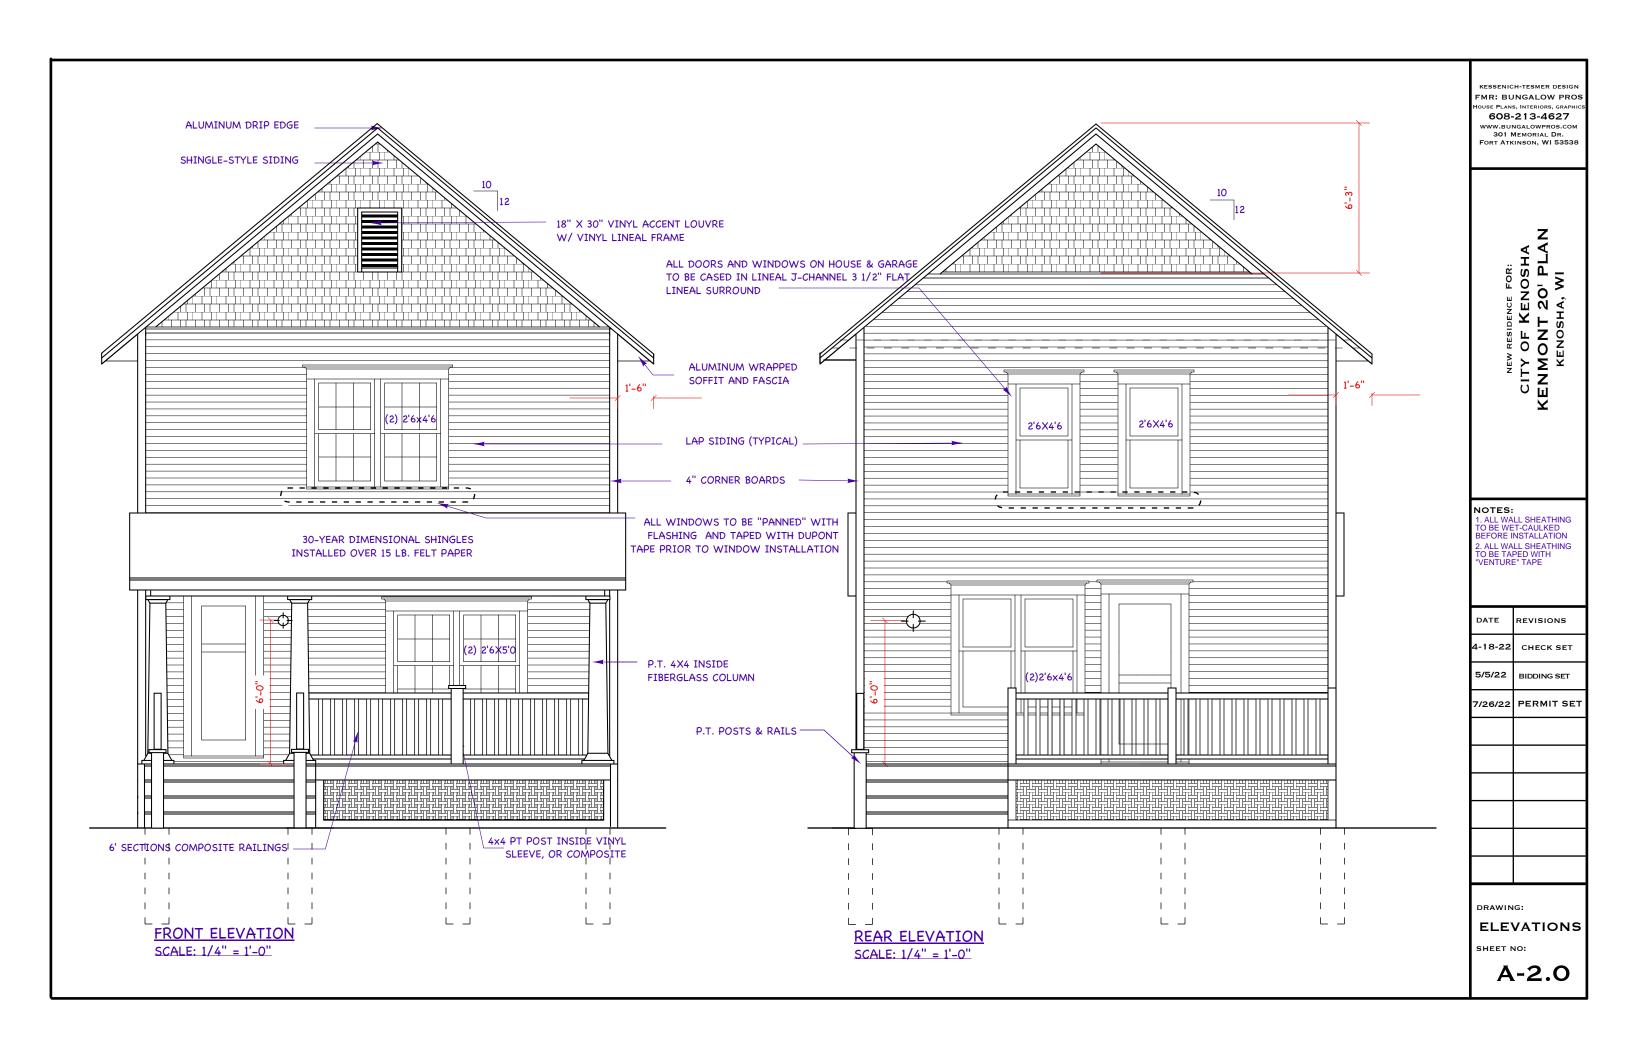

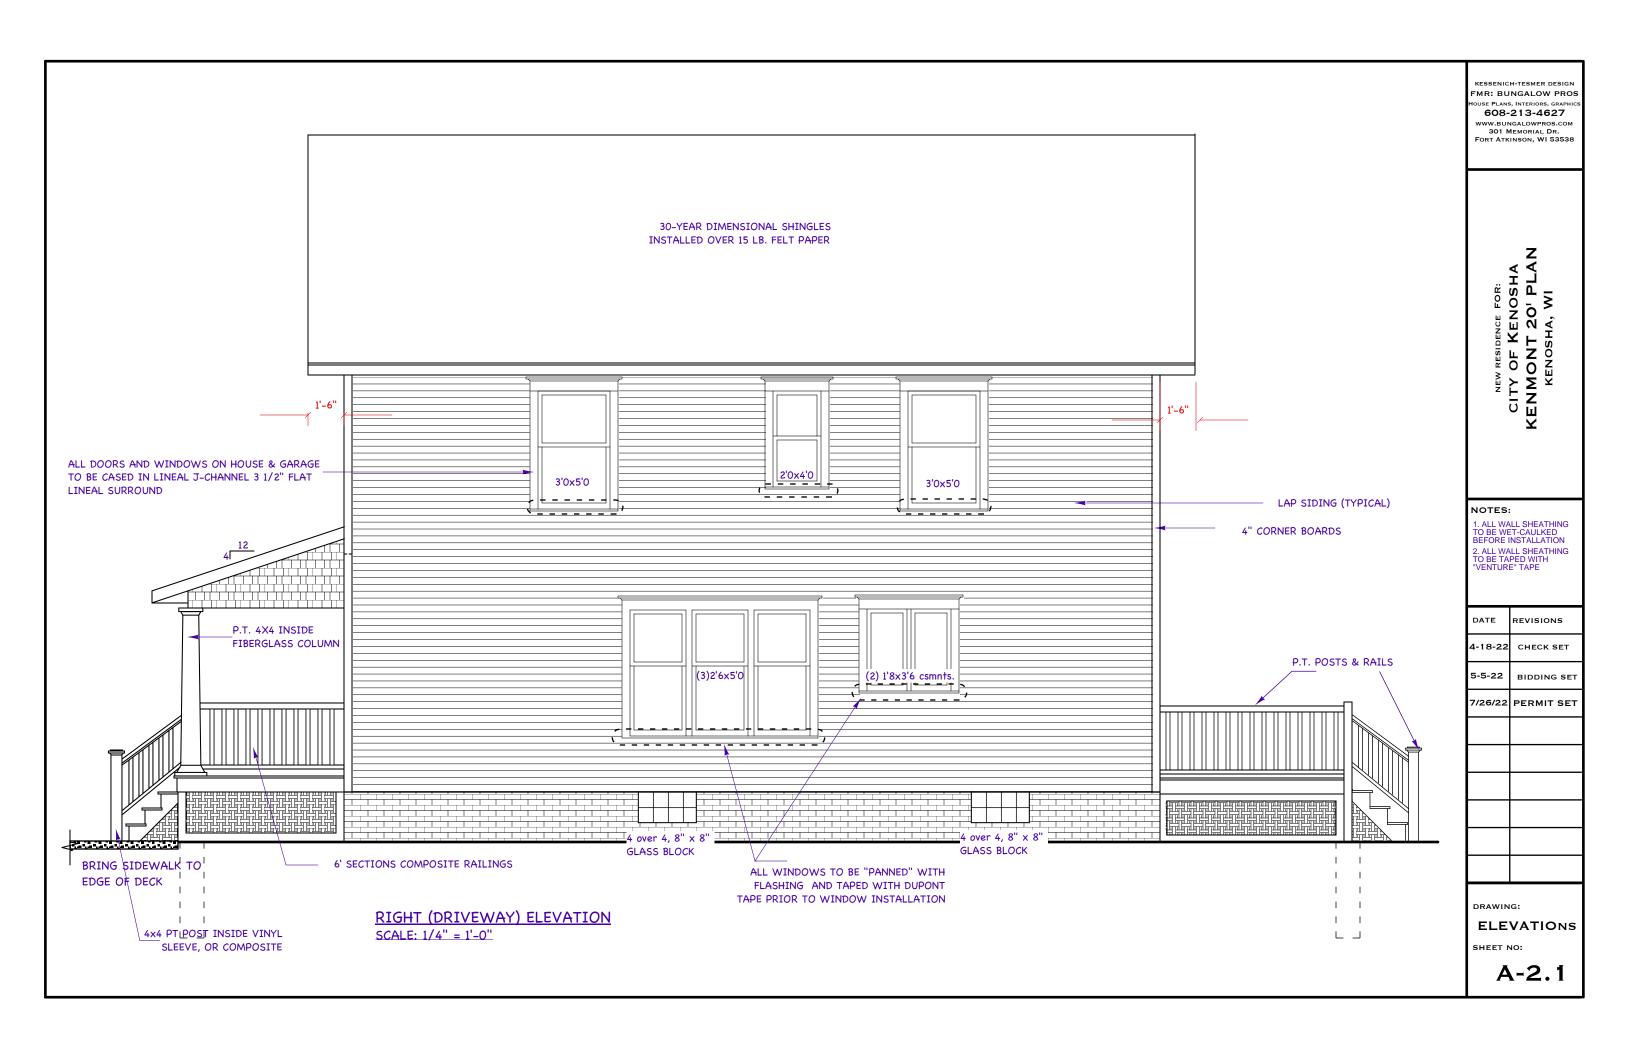


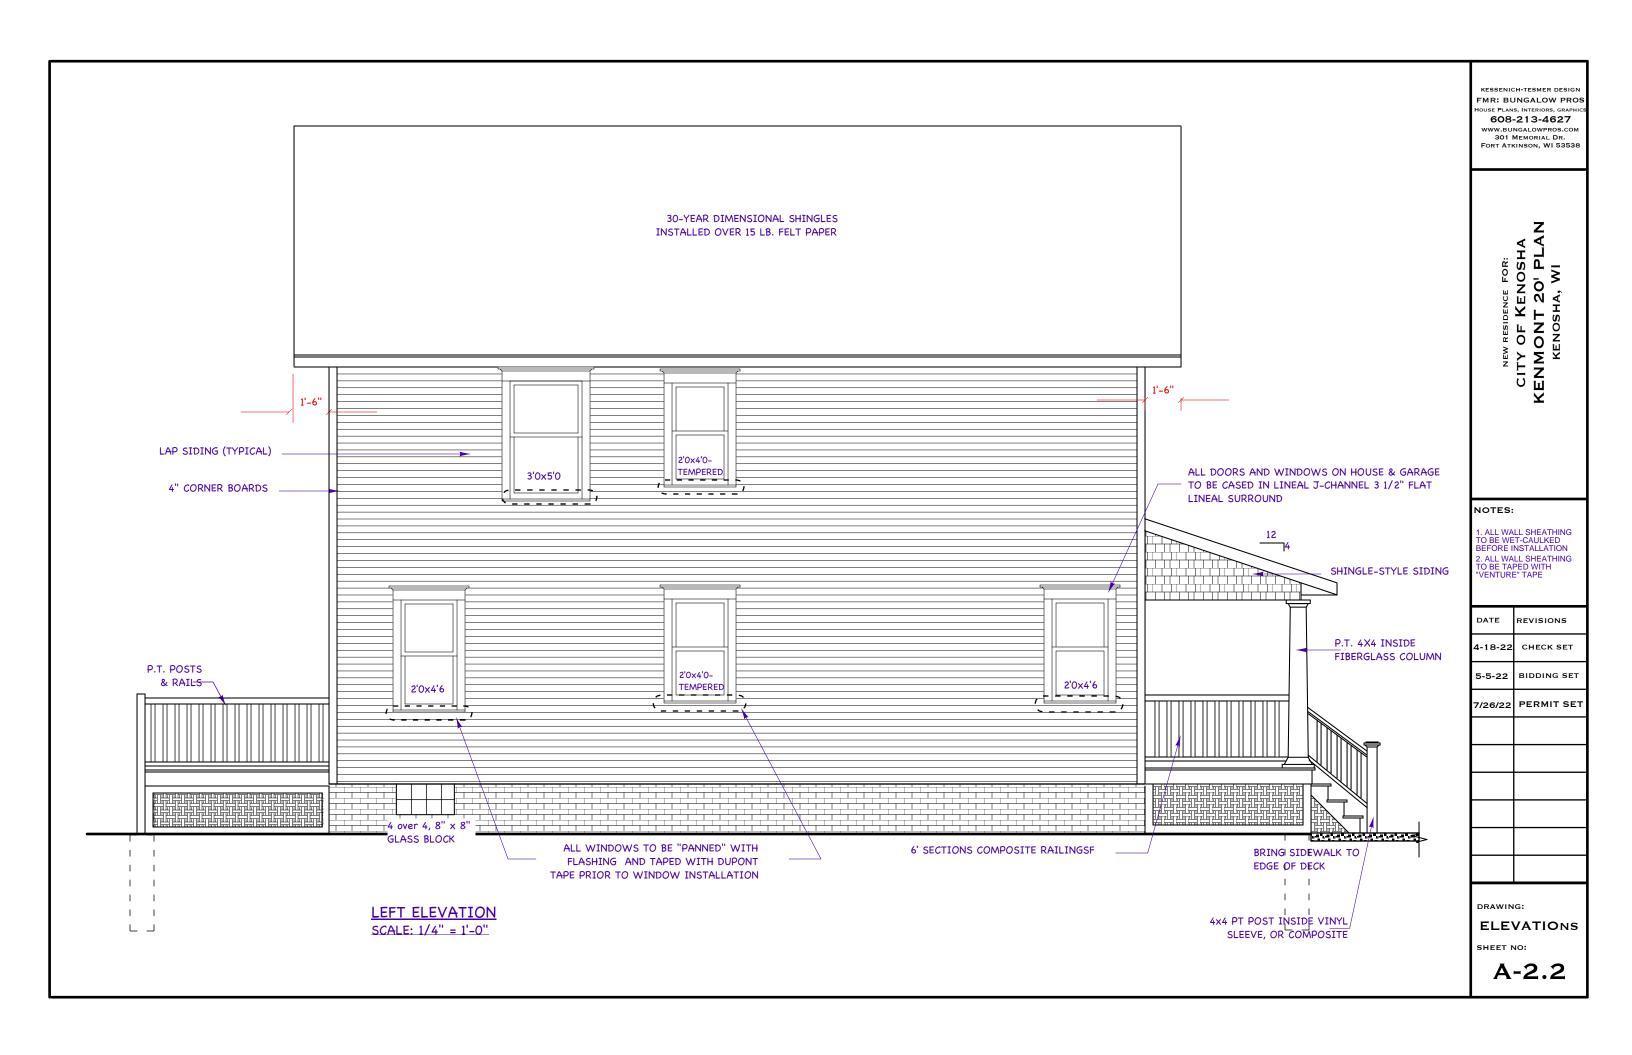

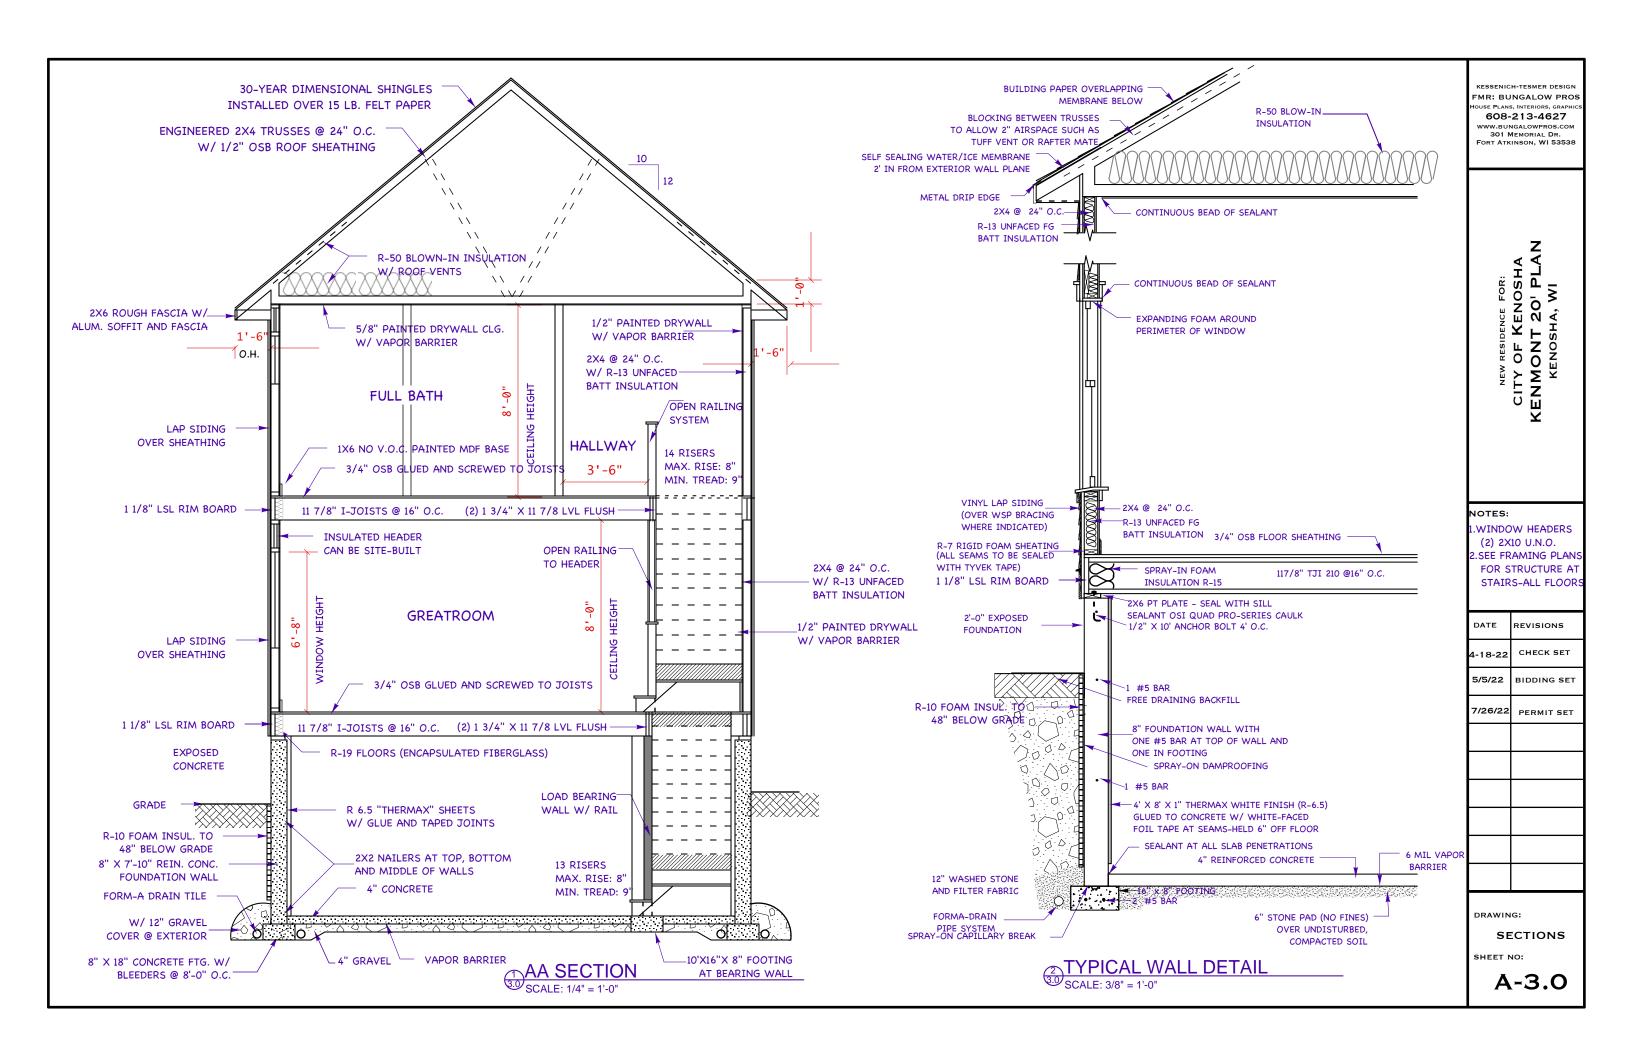

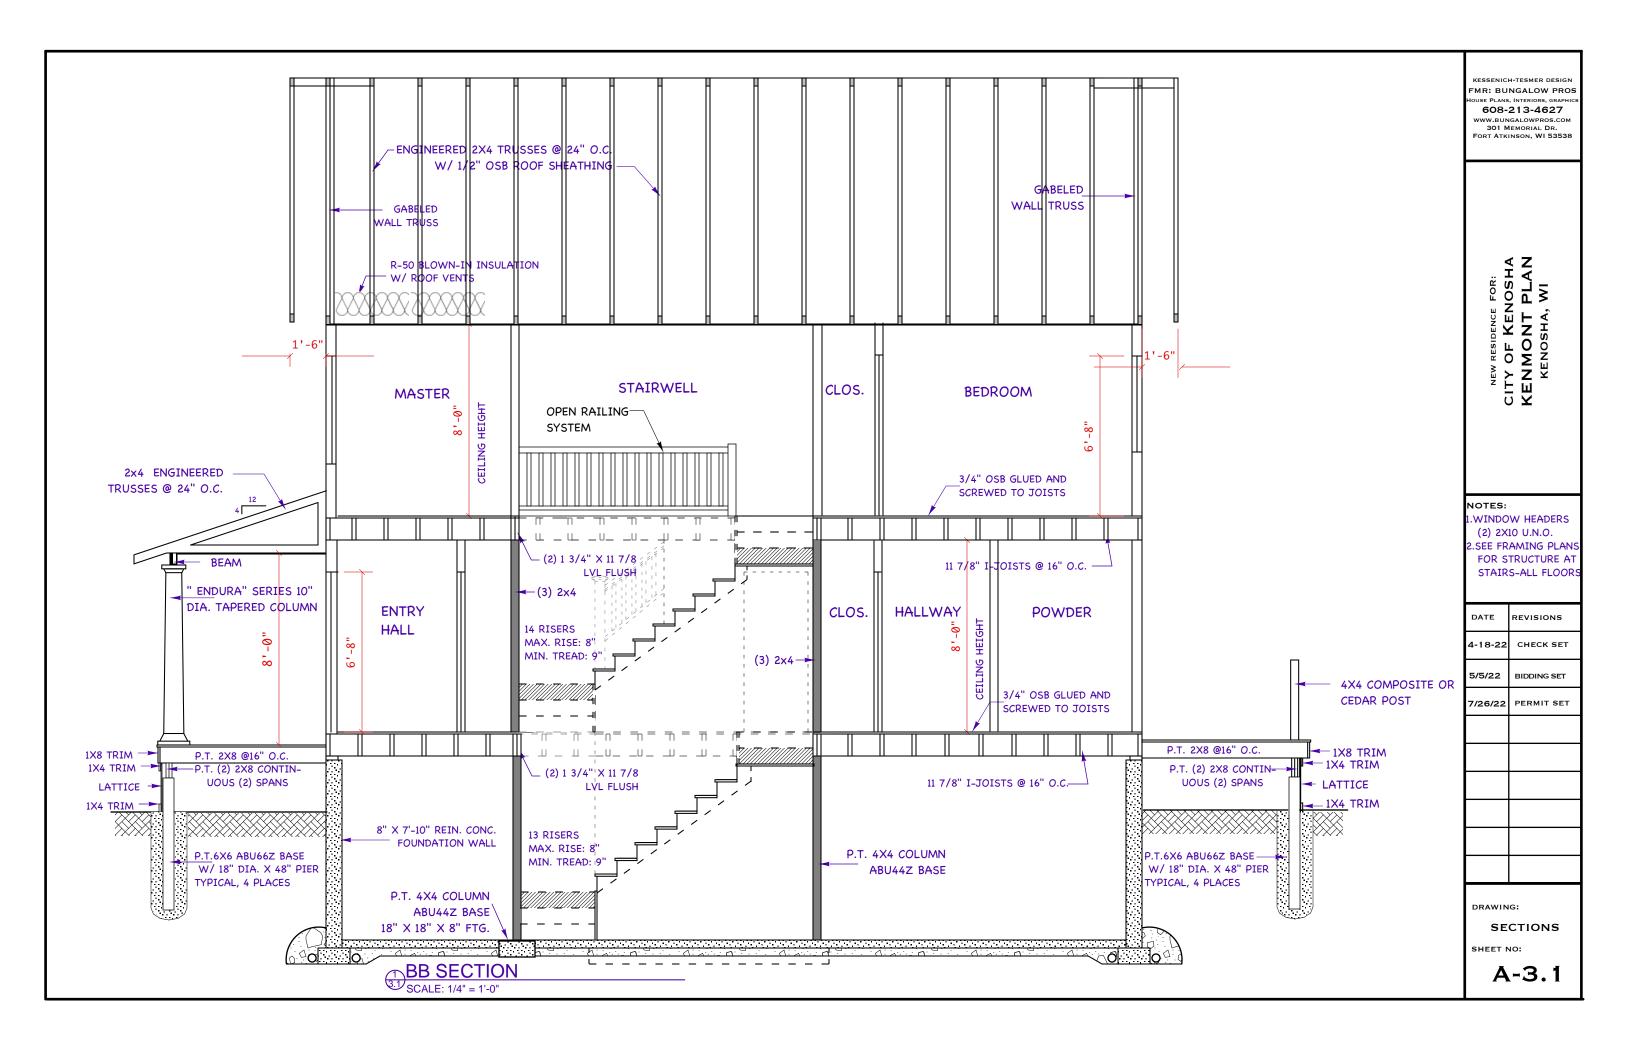



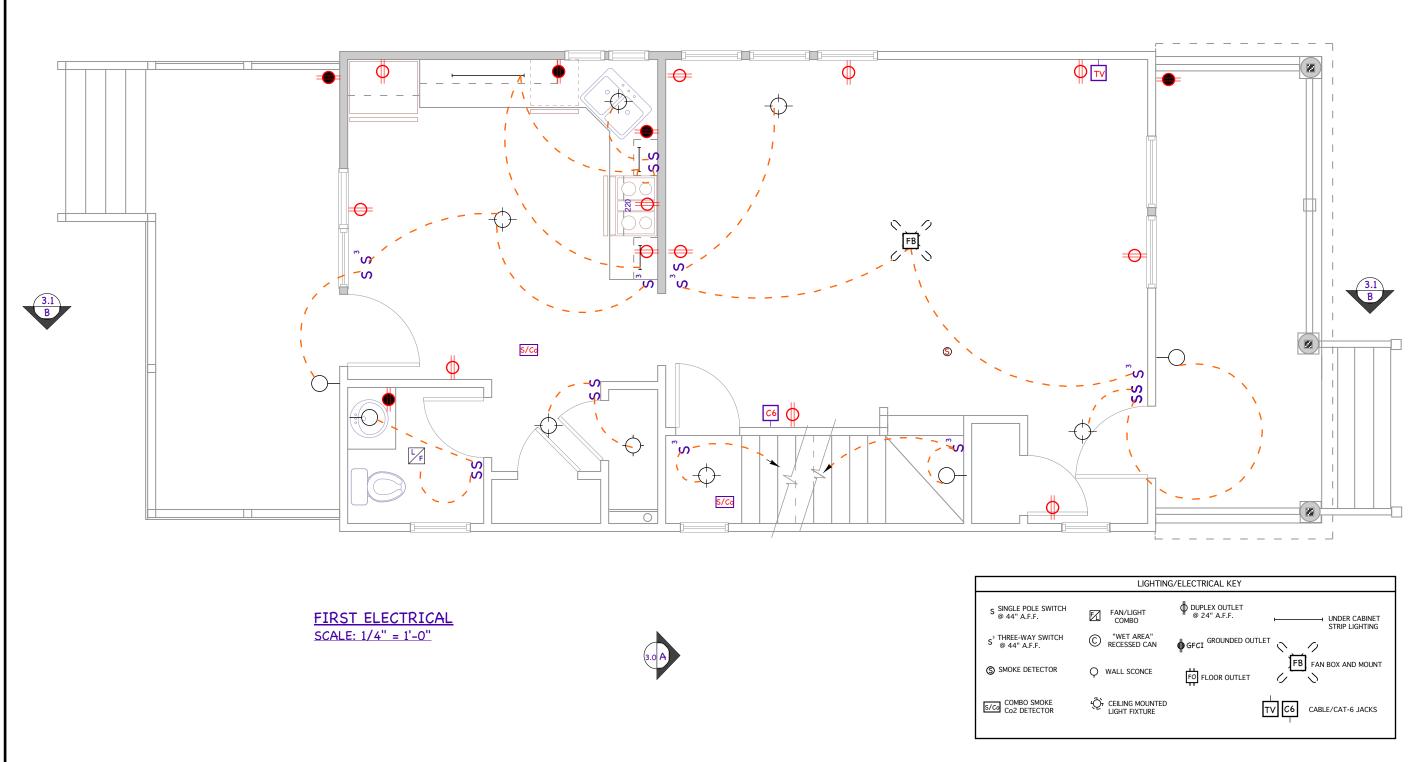

KESSENICH-TESMER DESIGN RESIDENTIAL ARCHITECTURE AND INTERIORS

AND INTERIORS
608-213-4627
WWW.BUNGALOWPROS.COM
301 MEMORIAL DR.
FORT ATKINSON, WI 53538

NEW RESIDENCE FOR:

CITY OF KENOSHA

KENMONT 20' PLAN

KENOSHA, WI

NOTES:

(1)ALL WINDOW DIMENSIONS ARE IN FEET AND INCHES

(2) ALL ROOM DIMENSIONS ARE FROM EXTERIOR OF OUTSIDE WALL TO MIDDLE OF INTERIOR WALL, UNLESS NOTED OTHERWISE

3) SEE SHEET S-1.4 FOR WALL BRACING WORKSHEET CODED TO THIS SHEET


4) ENGINEERING QUESTIONS MAY BE DIRECTED TO FOCUS ENGINEERING, 262-215-9295

| DATE | REVISIONS |
|---------|-------------|
| 4/21/22 | CHECK SET |
| 5/5/22 | BIDDING SET |
| 7/13/22 | FRAMING |
| 7/26/22 | PERMIT SET |
| | |
| | |
| | |
| | |
| | |

DRAWING:
FIRST
ELECTRICAL

E-1.0




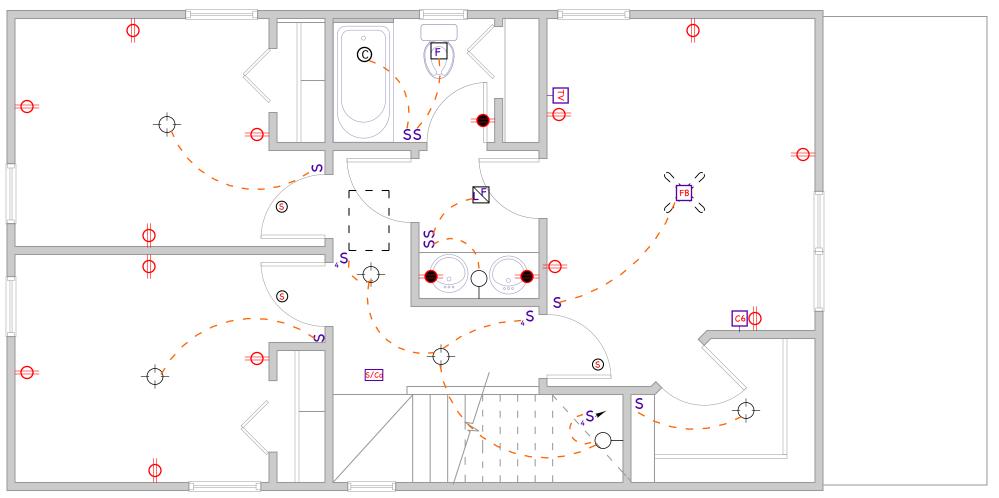

3.1 B

SECOND ELECTRICAL SCALE: 1/4" = 1'-0"



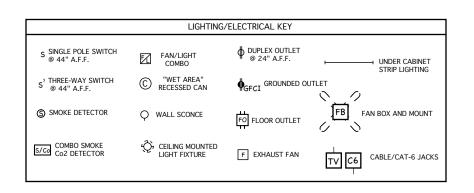

KESSENICH-TESMER DESIGN RESIDENTIAL ARCHITECTURE AND INTERIORS

AND INTERIORS
608-213-4627
WWW.BUNGALOWPROS.COM
301 MEMORIAL DR.
FORT ATKINSON, WI 53538

NEW RESIDENCE FOR:

CITY OF KENOSHA

KENMONT 20' PLAN

KENOSHA, WI

OTES

(1)ALL WINDOW DIMENSION ARE IN FEET AND INCHES

(2) ALL ROOM DIMENSIONS ARE FROM EXTERIOR OF OUTSIDE WALL TO MIDDLE OF INTERIOR WALL, UNLESS NOTED OTHERWISE

3) SEE SHEET S-1.4 FOR WALL BRACING WORKSHEET CODED TO THIS SHEET


4) ENGINEERING QUESTIONS MAY BE DIRECTED TO FOCUS ENGINEERING, 262–215–9295

| | • |
|---------|-------------|
| DATE | REVISIONS |
| 4/21/22 | CHECK SET |
| 5/5/22 | BIDDING SET |
| 7/13/22 | FRAMING |
| 7/26/22 | PERMIT SET |
| | |
| | |
| | |
| | |
| | |
| | |

DRAWING:
SECOND
ELECTRICAL
SHEET NO:

E-2.0



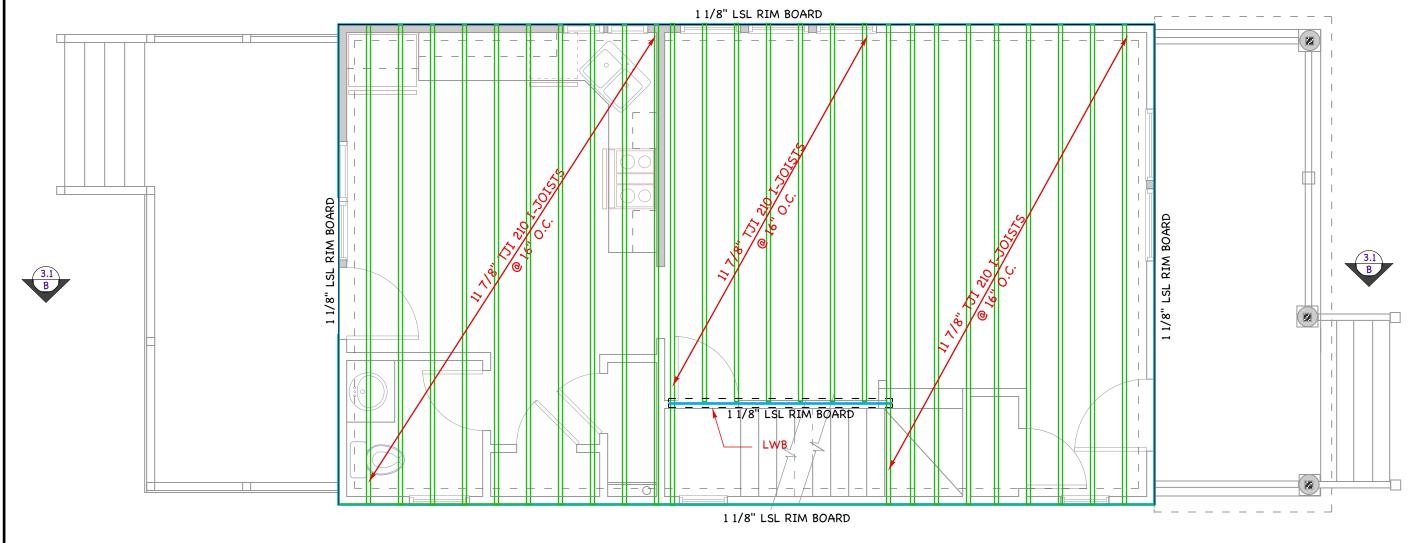

FIRST FLOOR FRAMING PLAN SCALE: 1/4" = 1'-0"



KESSENICH-TESMER DESIGN
RESIDENTIAL ARCHITECTURE
AND INTERIORS
608-213-4627

608-213-4627 WWW.BUNGALOWPROS.COM 301 MEMORIAL DR. FORT ATKINSON, WI 53538

NEW RESIDENCE FOR:
CITY OF KENOSHA
KENMONT 20' PLAN
KENOSHA, WI

NOTES:

(1)ALL WINDOW DIMENSIONS ARE IN FEET AND INCHES

(2) ALL ROOM DIMENSIONS ARE FROM EXTERIOR OF OUTSIDE WALL TO MIDDLE OF INTERIOR WALL, UNLESS NOTED OTHERWISE

3) SEE SHEET S-1.4 FOR WALL BRACING WORKSHEET CODED TO THIS SHEET


4) ENGINEERING QUESTIONS MAY BE DIRECTED TO FOCUS ENGINEERING, 262-215-9295

| DATE | REVISIONS |
|---------|-------------|
| 4/21/22 | CHECK SET |
| 5/5/22 | BIDDING SET |
| 7/13/22 | FRAMING |
| 7/26/22 | PERMIT SET |
| | |
| | |
| · | |

DRAWING:
FIRST
FRAMING
SHEET NO:

S-1.1



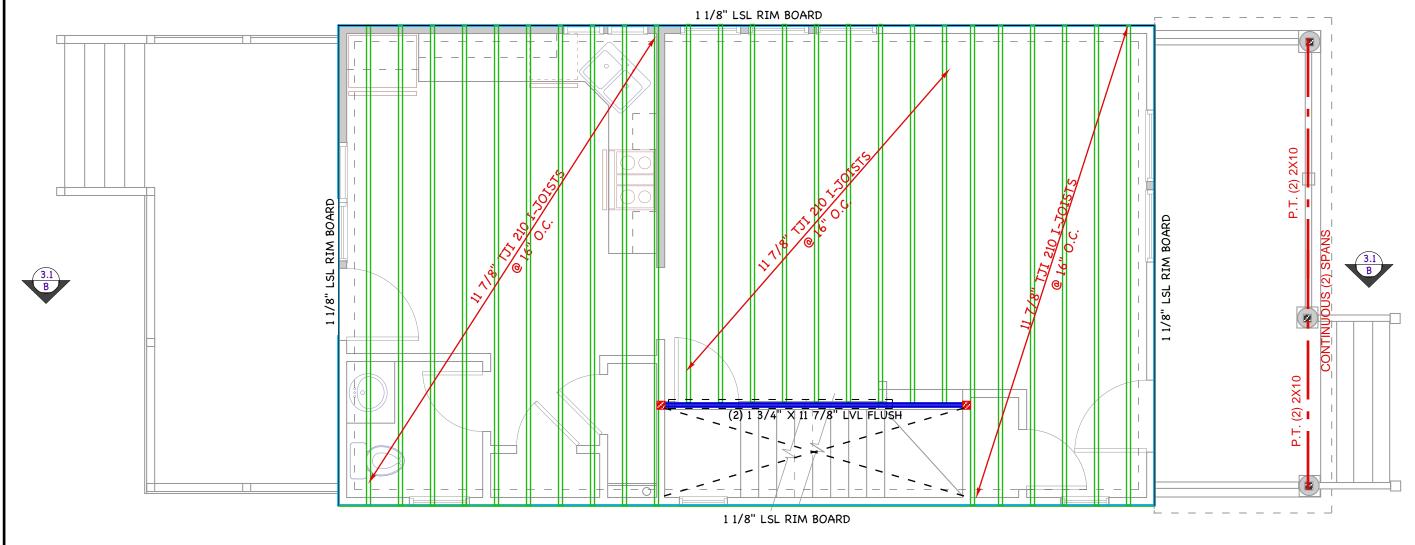

SECOND FLOOR FRAMING PLAN SCALE: 1/4" = 1'-0"



KESSENICH-TESMER DESIGN
RESIDENTIAL ARCHITECTURE
AND INTERIORS
608-213-4627

WWW.BUNGALOWPROS.COM 301 MEMORIAL DR. FORT ATKINSON, WI 53538

NEW RESIDENCE FOR:
CITY OF KENOSHA
KENMONT 20' PLAN
KENOSHA, WI

NOTES:

(1)ALL WINDOW DIMENSIONS
ARE IN FEET AND INCHES

(2) ALL ROOM DIMENSIONS ARE FROM EXTERIOR OF OUTSIDE WALL TO MIDDLE OF INTERIOR WALL, UNLESS NOTED OTHERWISE

3) SEE SHEET S-1.4 FOR WALL BRACING WORKSHEET CODED TO THIS SHEET


4) ENGINEERING QUESTIONS MAY BE DIRECTED TO FOCUS ENGINEERING, 262-215-9295

| DATE | REVISIONS |
|---------|-------------|
| 4/21/22 | CHECK SET |
| 5/5/22 | BIDDING SET |
| 7/13/22 | FRAMING |
| 7/26/22 | PERMIT SET |
| | |
| | |
| | |

DRAWING:
SECOND
FRAMING
SHEET NO:

S-1.2



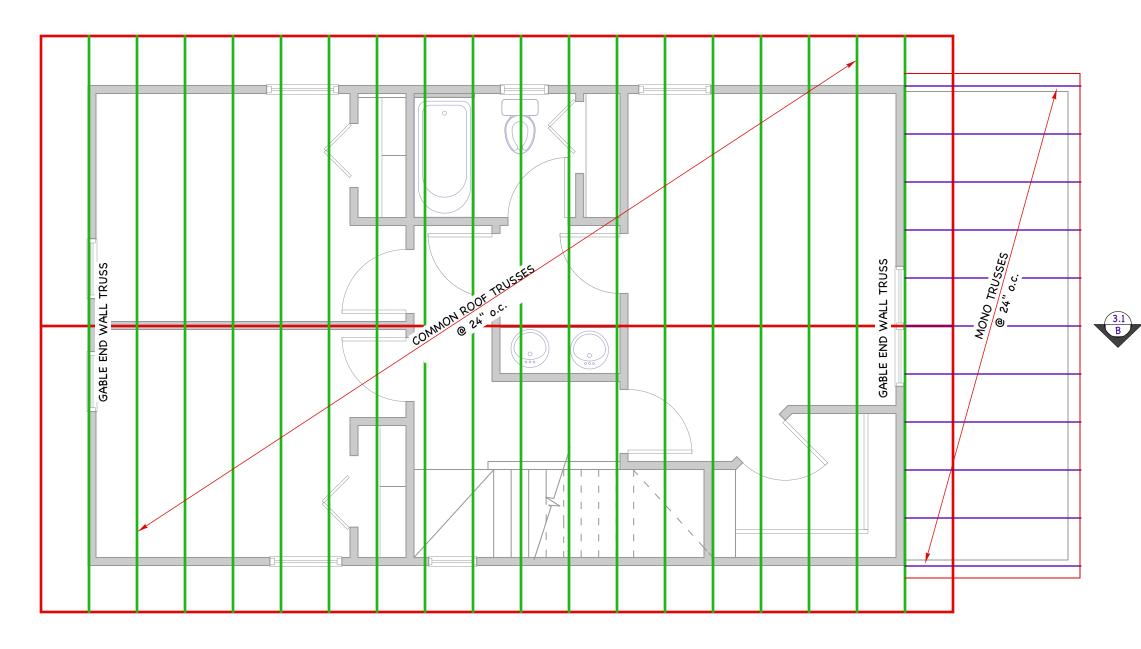



ROOF FRAMING PLAN SCALE: 1/4" = 1'-0"



KESSENICH-TESMER DESIGN RESIDENTIAL ARCHITECTURE AND INTERIORS

608-213-4627 WWW.BUNGALOWPROS.COM 301 MEMORIAL DR. FORT ATKINSON, WI 53538

NEW RESIDENCE FOR:
CITY OF KENOSHA
KENMONT 20' PLAN
KENOSHA, WI

NOTES:

(1)ALL WINDOW DIMENSIONS
ARE IN FEET AND INCHES

(2) ALL ROOM DIMENSIONS ARE FROM EXTERIOR OF OUTSIDE WALL TO MIDDLE OF INTERIOR WALL, UNLESS NOTED OTHERWISE

3) SEE SHEET S-1.4 FOR WALL BRACING WORKSHEET CODED TO THIS SHEET

4) ENGINEERING QUESTIONS MAY BE DIRECTED TO FOCUS ENGINEERING, 262-215-9295

| DATE | REVISIONS |
|---------|-------------|
| 4/21/22 | CHECK SET |
| 5/5/22 | BIDDING SET |
| 7/13/22 | FRAMING |
| 7/26/22 | PERMIT SET |
| | |
| | |
| | |
| | |

ROOF
FRAMING
SHEET NO:

S-1.3

S-1.4

Wall Bracing Worksheet per IRC 2012

Project KENMONT 20 For CITY OF KENOSHA

Eave to Ridge (ft) 10 Wind Speed (mph)

Exposure

Number of Stories

| Lev | el: Second | | | | | | | | | | | | |
|-----|------------|-----------|--------------|----------|------------|------|------|-------------|------|-----------------|------------------|-------|--------|
| | | Levels | | Wall Ht. | Table Len. | | | Adjustments | | | BWP Lengths (ft) | | |
| BWL | Type | Supported | Spacing (ft) | (ft) | # of BWL's | (ft) | Exp. | E-R | Ht | # BWL 's | Reqd. | Prov. | Block? |
| 1.2 | WSP | 1: Rf | 20.0 | 8.0 | 2 | 3.7 | 1.00 | 1.00 | 0.90 | 1.00 | 3.2 | 8.0 | No |
| 2.2 | WSP | 1: Rf | 20.0 | 8.0 | 2 | 3.7 | 1.00 | 1.00 | 0.90 | 1.00 | 3.2 | 8.0 | No |
| A.2 | WSP | 1: Rf | 34.0 | 8.0 | 2 | 6.1 | 1.00 | 1.00 | 0.90 | 1.00 | 5.3 | 10.7 | No |
| B.2 | WSP | 1: Rf | 34.0 | 8.0 | 2 | 6.1 | 1.00 | 1.00 | 0.90 | 1.00 | 5.3 | 10.7 | No |

| Level: | First | | | | | | | | | | | | |
|--------|-------|--------------|--------------|----------|------------|------------|------|-------------|------|-----------------|------------------|-------|--------|
| | | Levels | | Wall Ht. | | Table Len. | | Adjustments | | | BWP Lengths (ft) | | |
| BWL | Type | Supported | Spacing (ft) | (ft) | # of BWL's | (ft) | Exp. | E-R | Ht | # BWL 's | Reqd. | Prov. | Block? |
| 1.1 | WSP | 2: Rf + 1 F1 | 20.0 | 8.0 | 2 | 7.2 | 1.00 | 1.00 | 0.90 | 1.00 | 6.3 | 8.0 | Yes |
| 1.2 | WSP | 2: Rf + 1 F1 | 20.0 | 8.0 | 2 | 7.2 | 1.00 | 1.00 | 0.90 | 1.00 | 6.3 | 8.0 | Yes |
| A.1 | WSP | 2: Rf + 1 F1 | 20.0 | 8.0 | 3 | 7.2 | 1.00 | 1.00 | 0.90 | 1.30 | 8.2 | 8.0 | Yes |
| B.1 | GB-2 | 2: Rf + 1 F1 | 17.0 | 8.0 | 3 | 10.9 | 1.00 | 1.00 | 0.90 | 1.30 | 12.4 | 12.5 | Yes |
| C.1 | WSP | 2: Rf + 1 F1 | 14.0 | 8.0 | 3 | 5.3 | 1.00 | 1.00 | 0.90 | 1.30 | 6.0 | 8.0 | Yes |